


PARKING NUMBERS	
ON-GRADE	66 (17 SC / 11 ACC / 0 MB)
GROUND LEVEL	94 (19 SC / 12 ACC / 0 MB)
LEVEL 1A+1B	144 (26 SC / 0 ACC / 0 MB)
LEVEL 2A+2B	152 (32 SC / 0 ACC / 14 MB)
LEVEL 3A+3B	159 (24 SC / 0 ACC / 14 MB)
LEVEL 4A+4B	158 (25 SC / 0 ACC / 14 MB)
LEVEL 5A+5B	159 (24 SC / 0 ACC / 14 MB)
LEVEL 6A+6B	138 (23 SC / 9 ACC / 14 MB)
LEVEL 7A+7B	138 (13 SC / 6 ACC / 20 MB)
TOTAL	1248 (205 SC / 23 ACC / 90 MB)

<< NOT PART OF THE MSCP SCOPE

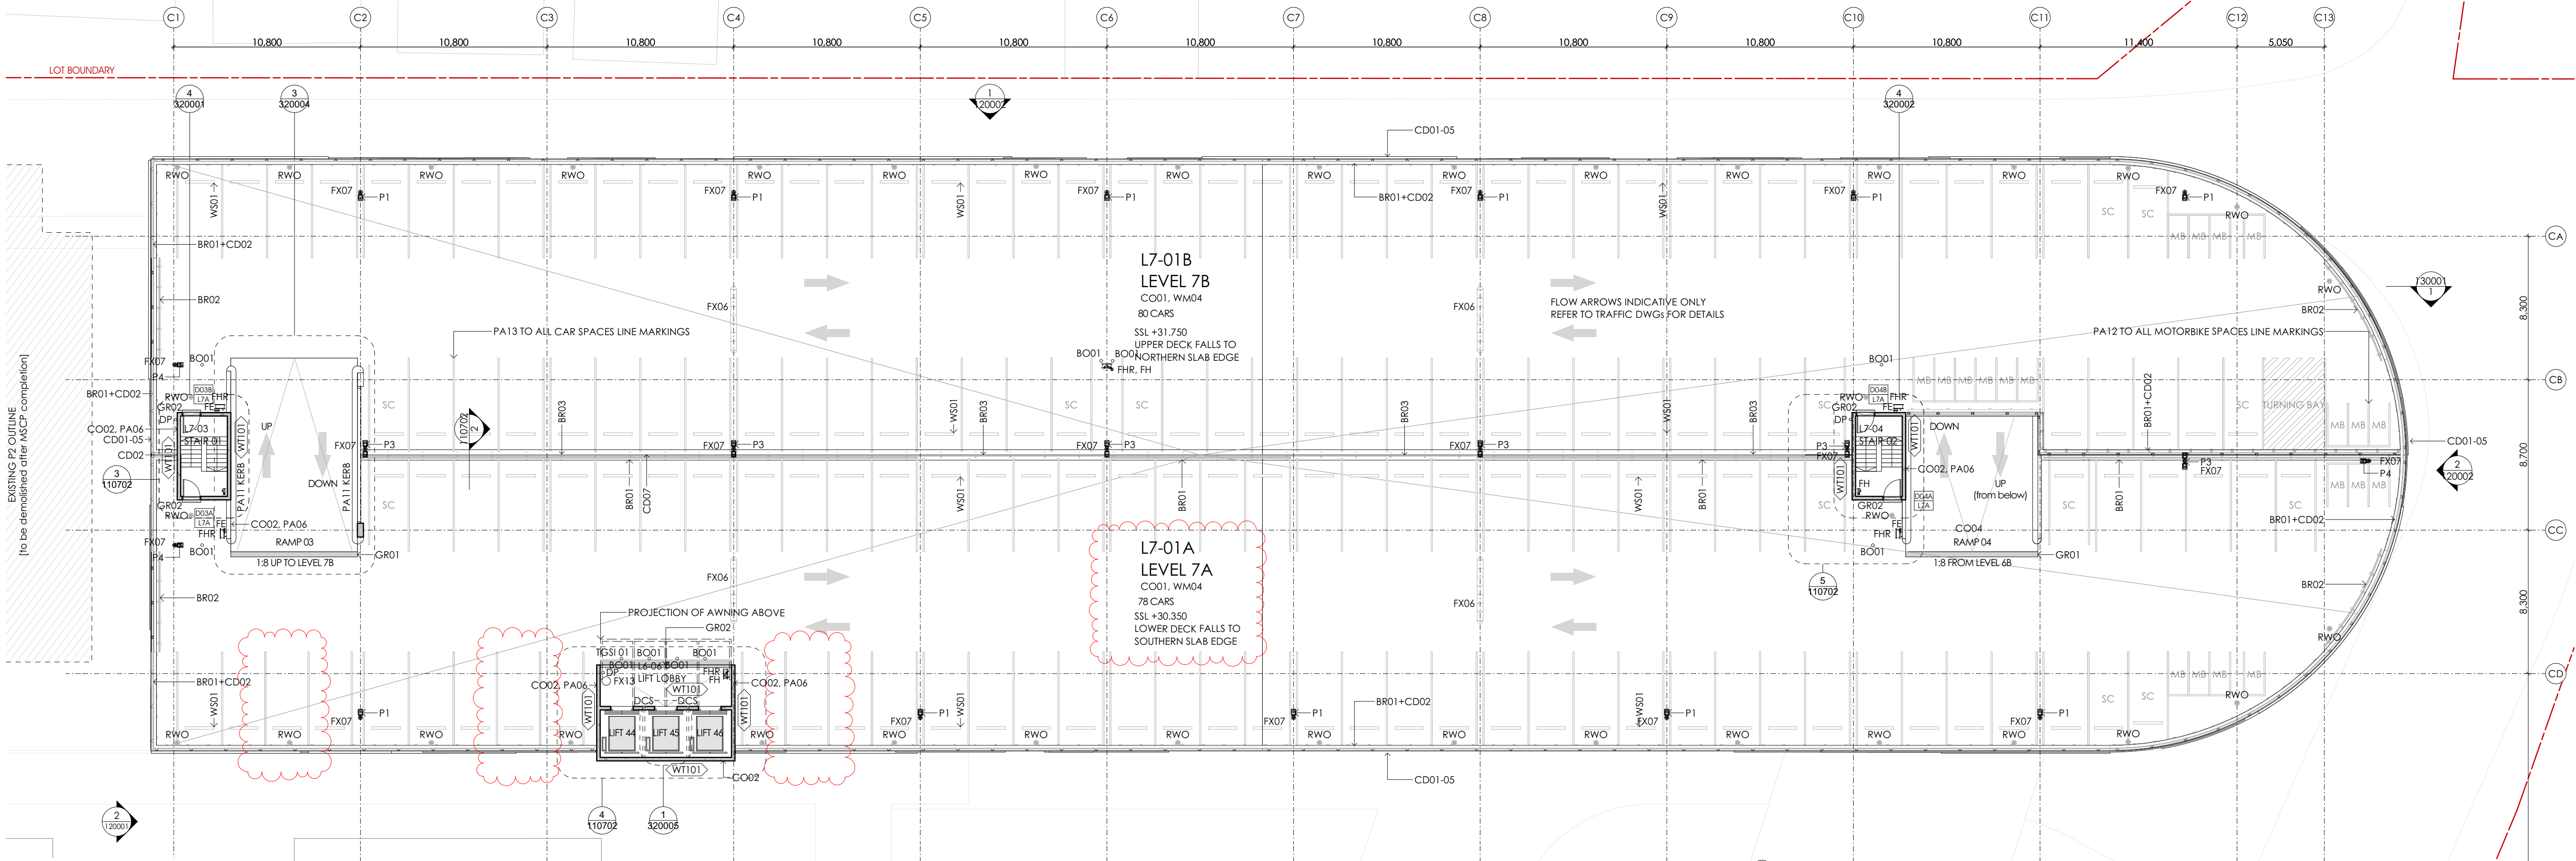

GENERAL NOTES

1. DRAWINGS TO BE READ IN CONJUNCTION WITH ALL DOCUMENTATION PROVIDED.
2. DRAWINGS TO BE READ IN CONJUNCTION WITH ALL SPECIALIST ENGINEERING CONSULTANT DOCUMENTATION. ALL ENGINEERING INFORMATION SHOWN IN THE ARCHITECTURAL DOCUMENTS ARE INDICATIVE ONLY.
3. FOR ALL EXTERNAL AREAS REFER TO CIVIL / LANDSCAPE DRAWINGS.
4. ALL CONCRETE FINISH TO BE CLASS 2 UNO (SHARP CORNER EDGES).
5. FOR BUILDING ROOF SAFETY PLEASE REFER TO FINISHES SCHEDULE.
6. FIRE CHAMF SLABING TO ALL VERT AREAS.
7. DENOTES WALLS THAT REQUIRE TO BE FIRE RATED. REFER TO BCA FOR FIRE RESISTANCE REQUIREMENTS.

WALL TYPES SCHEDULE

	IN-SITU CONCRETE	REFER TO BCA FOR FIRE RESISTANCE REQUIREMENTS. REFER TO STRUCT. ENG. DRAWINGS FOR WALL REQUIREMENTS.
	190 CONCRETE BLOCK	REFER TO BCA FOR FIRE RESISTANCE REQUIREMENTS. REFER TO STRUCT. ENG. DRAWINGS FOR WALL REQUIREMENTS.
	190 CORE-FILLED CONCRETE BLOCK	REFER TO BCA FOR FIRE RESISTANCE REQUIREMENTS. REFER TO STRUCT. ENG. DRAWINGS FOR WALL REQUIREMENTS.
	140 CONCRETE BLOCK	REFER TO BCA FOR FIRE RESISTANCE REQUIREMENTS. REFER TO STRUCT. ENG. DRAWINGS FOR WALL REQUIREMENTS.
	140 CORE-FILLED CONCRETE BLOCK	REFER TO BCA FOR FIRE RESISTANCE REQUIREMENTS. REFER TO STRUCT. ENG. DRAWINGS FOR WALL REQUIREMENTS.
	13MM PLASTERBOARD + 13MM STUDS	PLASTERBOARD + 13MM STUDS + 13MM PLASTERBOARD
	13MM PLASTERBOARD + 64 STUDS + INSULATION + 9MM FC SHEET	PLASTERBOARD + 13MM STUDS + 13MM PLASTERBOARD + 64 STUDS + INSULATION + 9MM FC SHEET
	13MM PLASTERBOARD DIRECT STICK	PLASTERBOARD
	50MM FURRING CHANNELS + INSULATION + 13MM PLASTERBOARD	50MM FURRING CHANNELS + 13MM PLASTERBOARD + INSULATION + 13MM PLASTERBOARD
	50MM FURRING CHANNELS + INSULATION + 13MM FIRE RATED PLASTERBOARD	50MM FURRING CHANNELS + 13MM FIRE RATED PLASTERBOARD + INSULATION + 13MM FIRE RATED PLASTERBOARD
	50MM FURRING CHANNELS + INSULATION + 9MM FC SHEET	50MM FURRING CHANNELS + 9MM FC SHEET + INSULATION + 9MM FC SHEET

2 SECTION DETAIL - L7 SPLIT LEVELS CLADDING SCALE: 1:20

3 ROOF PLAN - STAIR 01 WEST SCALE: 1:100

4 ROOF PLAN - LIFT LOBBY ROOF SCALE: 1:100

5 ROOF PLAN - STAIR 02 EAST SCALE: 1:100


NOTES

1. THIS DRAWING IS ISSUED UPON THE CONDITION IT IS NOT COPIED, REPRODUCED, REPAIRED OR DISCLOSED TO ANY UNAUTHORIZED PERSON EITHER WHOLLY OR IN PART WITHOUT PRIOR CONSENT IN WRITING OF fitzpatrick+partners.
2. DRAWINGS SHOW DESIGN INTENT ONLY. SHOP DRAWINGS ARE TO BE PROVIDED FOR APPROVAL PRIOR TO CONSTRUCTION OR MANUFACTURE.
3. DO NOT SCALE DRAWINGS. CHECK DIMENSIONS BEFORE COMMENCING WORK.
4. INCONSISTENCIES ARE TO BE REPORTED TO fitzpatrick+partners.
5. NUMBERS FOLLOWING AN ABBREVIATION DENOTE A PARTICULAR TYPE OF ITEM. FOR EXPLANATION OF ITEM TYPES REFER TO SPECIFICATION AND FINISHES SCHEDULE.
6. CONSULTANT DETAILS ARE INCLUDED FOR EASE OF REFERENCE ONLY.
7. ALL DRAWINGS TO BE PRINTED IN COLOUR.

ABBREVIATIONS

COL	COLUMN	MECH	MECHANICAL
CCS	CHECK ON SITE	MIN	MINIMUM
DP	DOWNPIPE	MAX	MAXIMUM
ELC	ELECTRICAL	NOM	NOMINAL
EX	EXISTING	RL	RELATIVE LEVEL
FCL	FINISHED CEILING LEVEL	RWO	RAIN-WATER OUTLET
FRL	FINISHED FLOOR LEVEL	SW	SWILAR
FH	FIRE HYDRANT	SPC	SPECIFICATION
FHR	FIRE HOSE REEL	SSL	STRUCTURAL SLAB LEVEL
FRL	FIRE RESISTANCE LEVEL	TBC	TO BE CONFIRMED
FS	FIRE STAIR	TOW	TOP OF WALL
FW	FLOOR WASTE	TPF	TYPICAL
HYD	HYDRAULIC	U/S	UNDERSIDE
ENG	ENGINEERS	STRUC	STRUCTURAL
DWG	DRAWINGS	SFCS	SPECIFICATIONS

KEY PLAN

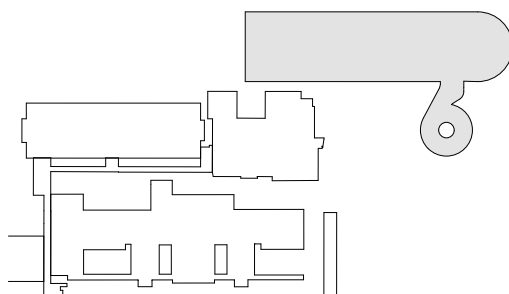

AMENDMENTS

REV	DATE	DESCRIPTION	CHK
10	4/02/2021	FOR CONSTRUCTION	RP
09	1/12/2020	FOR CONSTRUCTION	RP
08	19/11/2020	FOR COORDINATION	RP
07	23/10/2020	FOR COORDINATION 100%	RP
06	20/10/2020	FOR COORDINATION	RP
05	25/09/2020	FOR COORDINATION	RP
04	12/05/2020	FOR TENDER	BC
03	16/04/2020	FOR TENDER	BC
02	30/03/2020	DESIGN DEVELOPMENT	BC

PROJECT

LIVERPOOL HEALTH & ACADEMIC PRECINCT

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NSW
South Western Sydney
Local Health District
ELIZABETH STREET LIVERPOOL, NSW

CLIENT

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NSW
Infrastructure
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MSCP CONTRACTOR

ADCO
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PROJECT MANAGER

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STRUCTURAL / CIVIL

TTW
Taylor
Thomson
Whitting

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MECHANICAL / ELECTRICAL / SECURITY

Stantec

LEVEL 4/99 WALKER ST, NORTH SYDNEY NSW 2060


HYDRAULIC / FIRE

Warren
Smith &
Partners
LEVEL 9/233 CASTLEREAGH ST, SYDNEY NSW 2000

LANDSCAPE ARCHITECT

CLDUSTON ASSOCIATES
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PROJECT NORTH

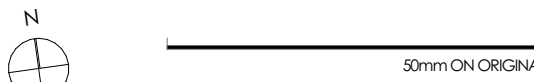

FOR CONSTRUCTION

DRAWING

GENERAL ARRANGEMENT PLANS -
LEVEL 7

DRAWN	APPROVED	PRINT DATE
AB	RP	4/02/2021
SCALE	PROJECT NO.	STATUS
1:200, 1:20, 1:100@A1	21807	CONSTRUCTION DOCUMENTATION
DRAWING NO.	ISSUE	
LHAP-AR-FA-DRG-CP-110702	10	